


**Application No: DC/17/04484**

**Address: The Newsagent Bell Hill  
Cottage  
The Street  
Rickingham Inferior  
IP22 1BN**

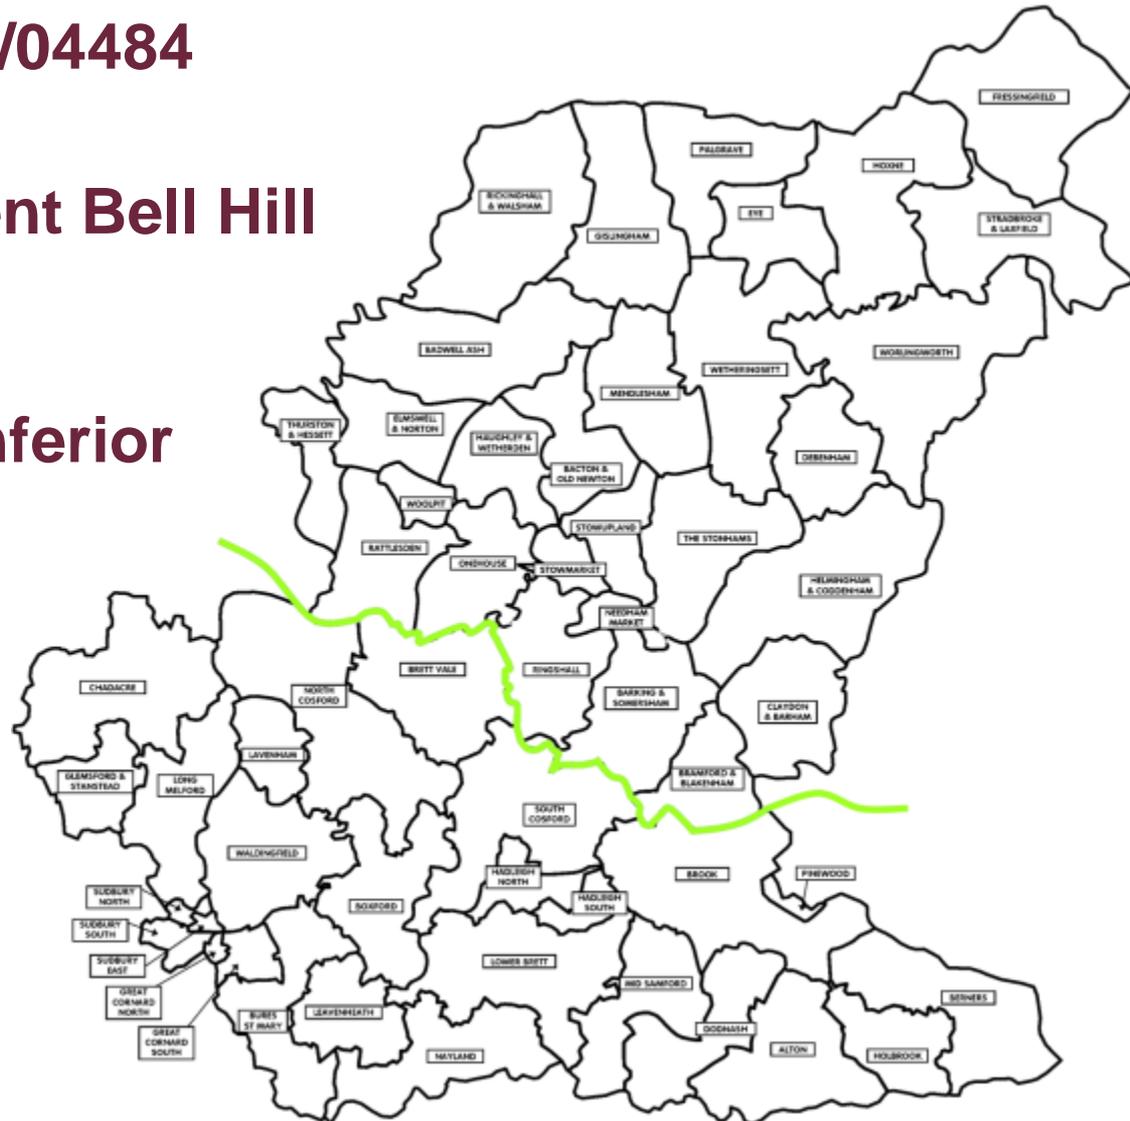




## Verbal Updates:

- Confirmation and summary of any 3<sup>rd</sup> Party representations received not previously issued to members.
- Confirmation and summary of any consultee responses received not previously issued to members
- Confirmation of any changes to recommendation, conditions or reasons.









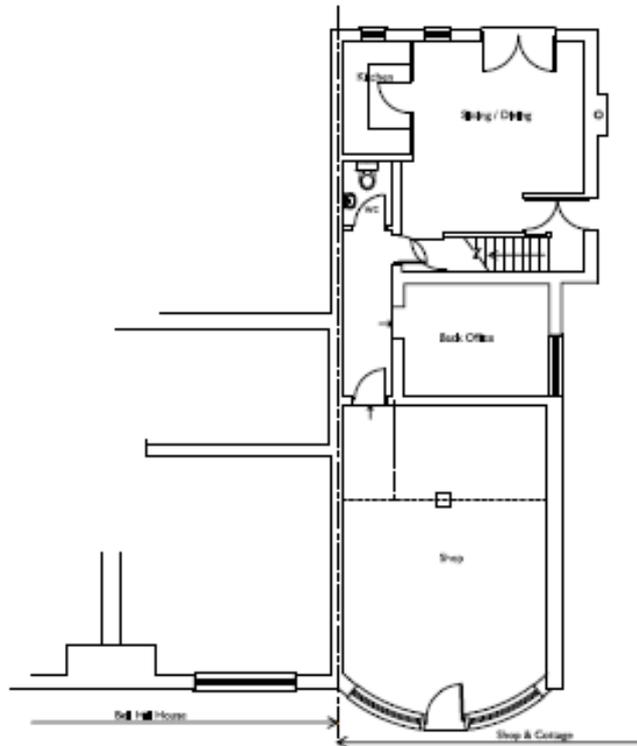

Ground Floor Plan

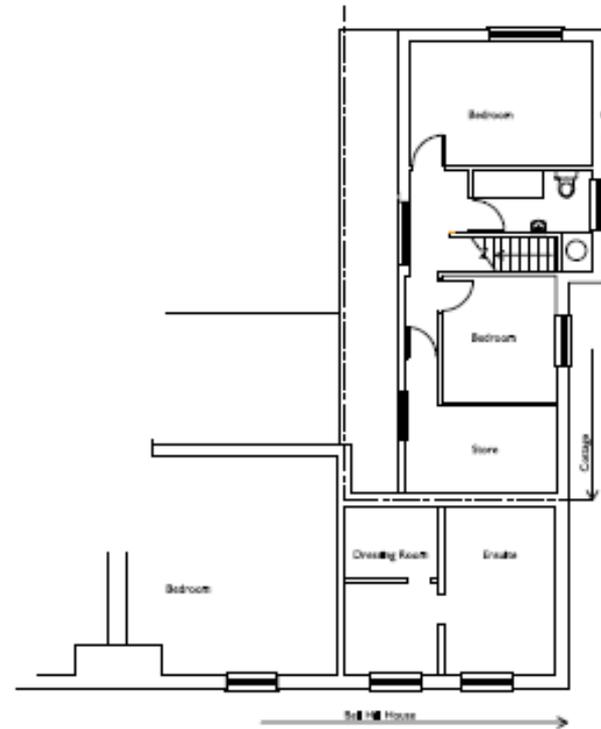


First Floor Plan

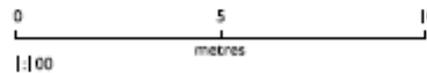


<small>Notes &amp; alterations are indicated on this plan by cutting or protruding symbols. Unmarked hatchwork requirements are that for all materials. Do not scale from this or any other drawing. Any discrepancies, contact the issuer. This drawing or any of its contents cannot be used except with the express written permission of the issuer. Without such permission no responsibility is taken for its content.</small>			
<b>ROBERTS.MOLLOY ASSOCIATES</b> architects and consultants		3 Church Lane Bressingham close Norfolk IP22 3AE	<b>ROBERTS.MOLLOY ASSOCIATES @</b> Tel: 01379 687755 E-mail: info@robertsmolloy.co.uk
desc: EXISTING FLOOR PLANS		project: THE OLD NEWSAGENTS, THE STREET, RICKINGHALL	
scale: 1:100@A3	date: July	job no: RTS	sheet: 02


# Existing Elevations

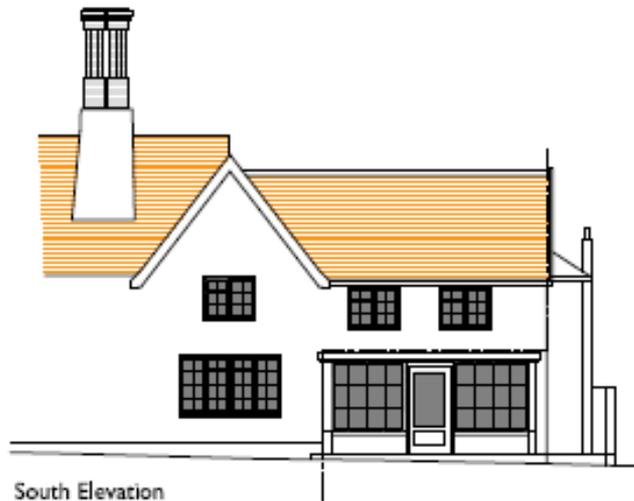


South Elevation

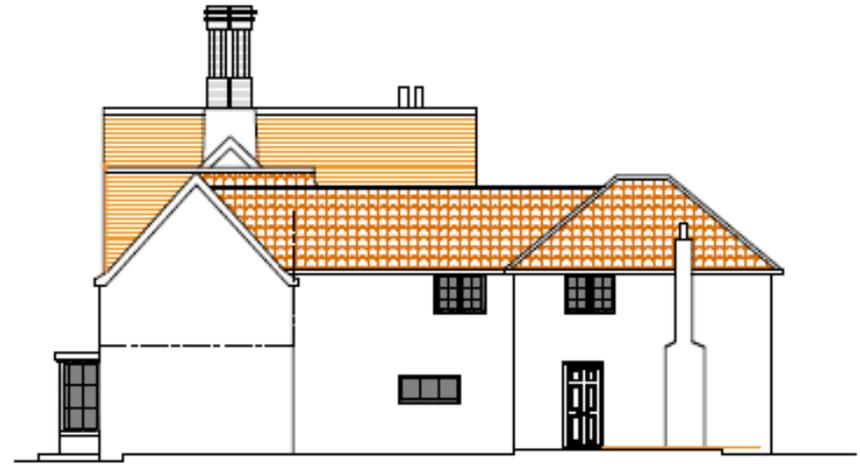

East Elevation

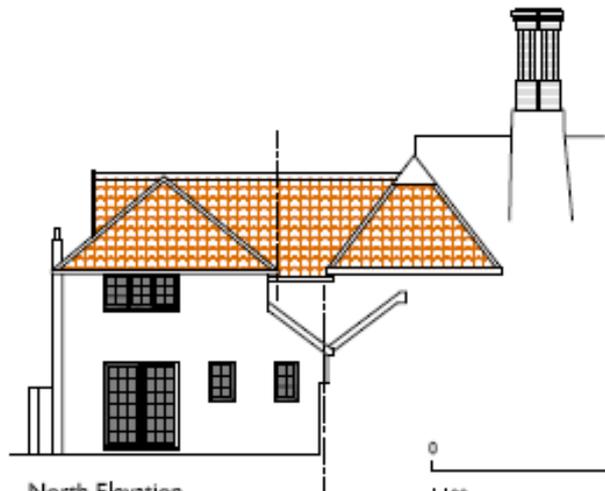


North Elevation

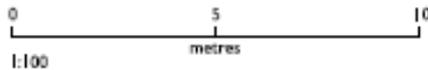

Ref.	Date	Revision		
<p><small>Unless otherwise stated, all dimensions are to be taken from the finished face of the work. All dimensions are to be taken from the finished face of the work. Do not scale from this or any other drawing. Any discrepancies, contact the issuer. This drawing or any of its contents cannot be used except with the express written permission of the issuer. Without such permission no responsibility is taken for its content.</small></p>				
<p><b>ROBERTS.MOLLOY ASSOCIATES</b> architects and consultants</p>			<p>3 Church Lane Bramingham class Norfolk IP22 2AE</p>	<p>ROBERTS.MOLLOY ASSOCIATES © Tel: 01309 887755 E-mail: info@robertsmolloy.co.uk</p>
<p>drawn: EXISTING ELEVATIONS</p>			<p>project: THE OLD NEWSAGENTS, THE STREET, RICKINGHALL</p>	
<p>scale: 1:100@A3</p>		<p>date: July 2017</p>	<p>job no: RTS</p>	<p>draw no: 03</p>



# Ceiling Plan

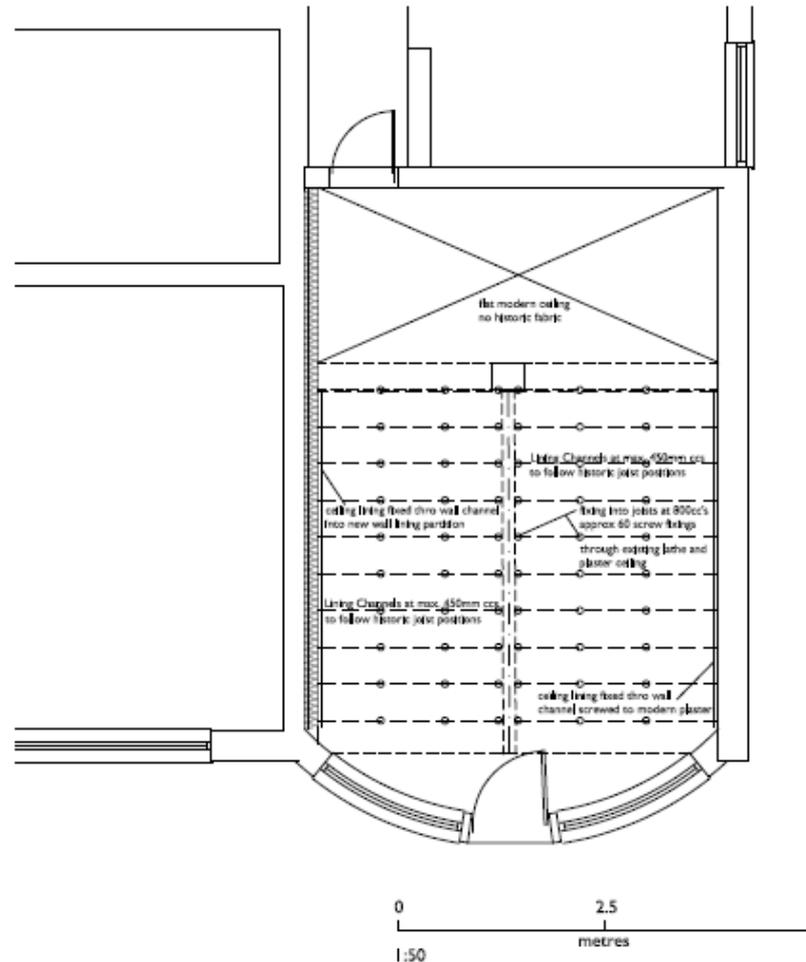

Ref.	Date	Revision	<p>Ensure all dimensions are checked on site prior to ordering of prefabricated elements. Ensure minimum headroom requirements are met for all entrances. Do not scale from this or any other drawing. Any discrepancies, contact the issuer. This drawing or any of its contents cannot be used except with the express written permission of the issuer. Without such permission no responsibility is taken for its content.</p>	
<b>ROBERTS MOLLOY</b> architects & consultants			3 church lane bressingham ddb norfolk IP22 2AE	<b>ROBERTS MOLLOY LIMITED</b> © Tel: 01379 687706 E-mail: <a href="mailto:info@robertsmolloy.co.uk">info@robertsmolloy.co.uk</a>
DETAIL: PROPOSED FIXING POINTS FOR CEILING LINING		PROJECT: THE OLD NEWSAGENTS BELL HILL COTTAGE, RICKINGHALL		
Scale: 1:50@A4	Date: January 2018	Job No. RTS	DRG No. 05	

# Extract from British Gypsum

C06 Room and ceiling Gyplime systems


### Gyplime systems performance (continued)

Upgrading existing solid timber joist floors - ceiling retained  
 Upgrade to an existing floor requires access from below only

For details of when to specify fire resistance using BS  
 Refer to C02, S02, P02



Table 3 – Solutions to satisfy the requirements of BS 476 Part 22: 1987

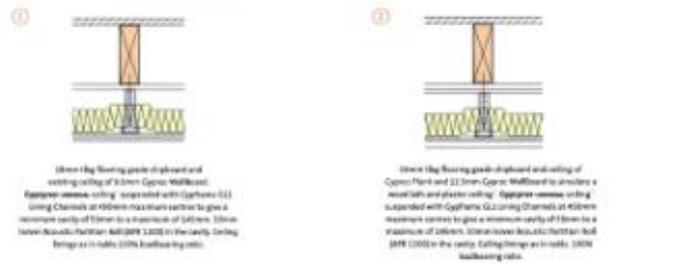

Detail	Board type	Lining thickness mm	Joist centres mm	Joist size mm	Sound insulation		System reference
					Airborne $R_w$ dB	Impact $L_w$ dB	
<b>1</b> minutes fire resistance <b>BS</b>							
<b>2</b>	Gyproc FireLine	3 x 12.5	400	135 x 45	53	94	C154921
<b>3</b> minutes fire resistance <b>BS</b>							
<b>1</b>	Gyproc FireLine	2 x 12.5	400	135 x 45	56	82	C154925
<b>2</b>	Gyproc FireLine	2 x 12.5	400	135 x 45	59	59	C154926

For further assistance in choosing the right solution for your project, try the White Book System Selector, an on-line tool that enables quick and easy filtering by performance criteria. It provides system specific information downloads including BIM (Revit) objects. Go to [british-gypsum.com](http://british-gypsum.com)

Gyplime G12 Trimmer Connectors are bent at a position between the first and fourth holes along forming a 50mm horizontal leg to form a right angle and fixed through the existing ceiling with suitable fixings. Alternatively use Gyplime G12 G13 or G12 Trimmer. Fixing lath and plaster ceiling (up to 30mm thick) should be supported by a broken wire, securely fixed to the joist.

**NB** The fire resistance and sound insulation performance are for imperforate partitions, with ceilings incorporating boards with all joints taped and fixed, or trimmed according to British Gypsum's recommendations. The quoted performance are achieved only if British Gypsum and lath & plaster board components are used throughout, and the Company's fixing recommendations are strictly observed. Any variation in the specifications should be checked with British Gypsum.

**MB** For non-timber floors, overlay with 6mm plywood and ensure all joints are staggered.